


PROPOSED


Proposed Fencing Enclosure Elevations

SCALE 1:50


NOTES: All measurements are in mm unless otherwise specified. Do not scale from this drawing. Contractor to check dimensions on site and inform AF Architecture of discrepancies if required. This drawing is subject to Copyright.

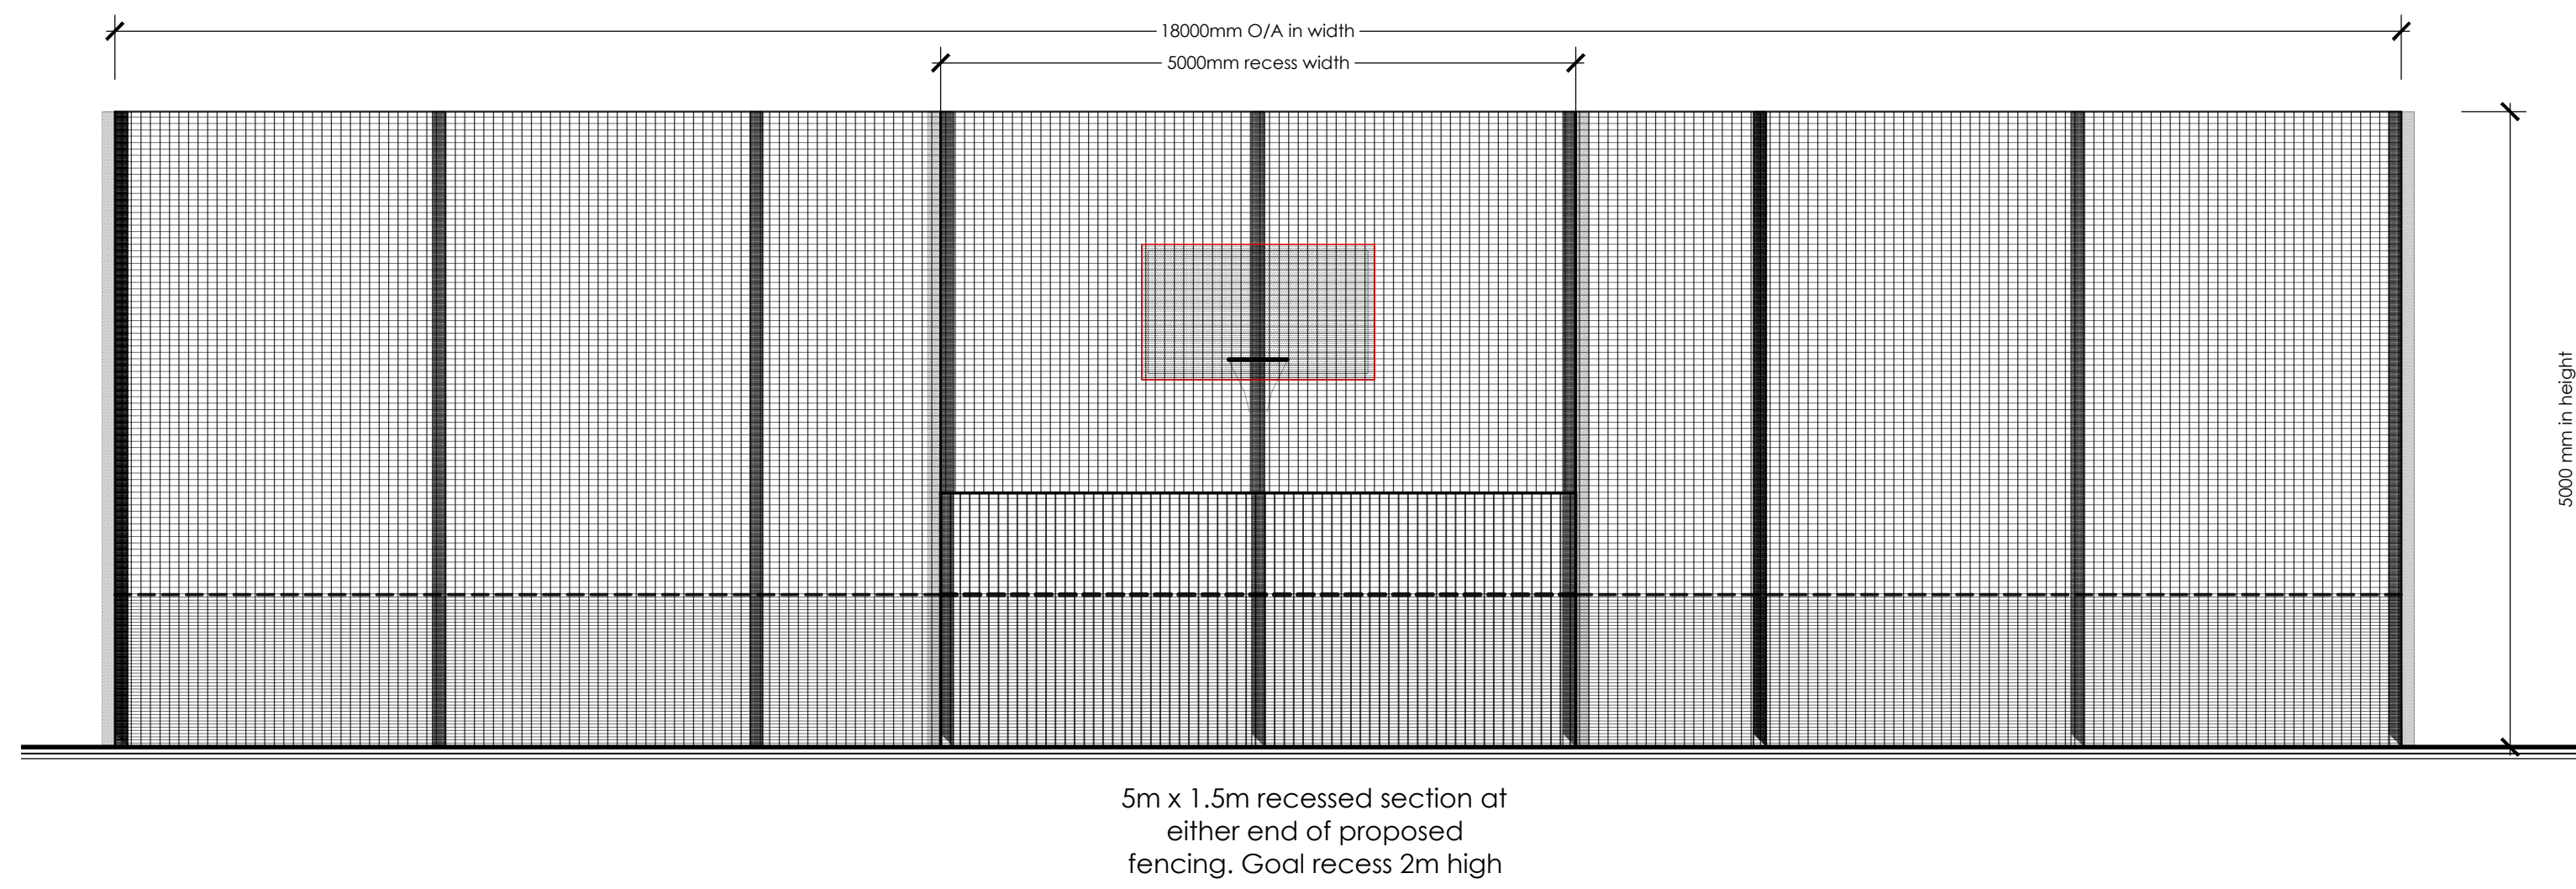

NORTH / FRONT

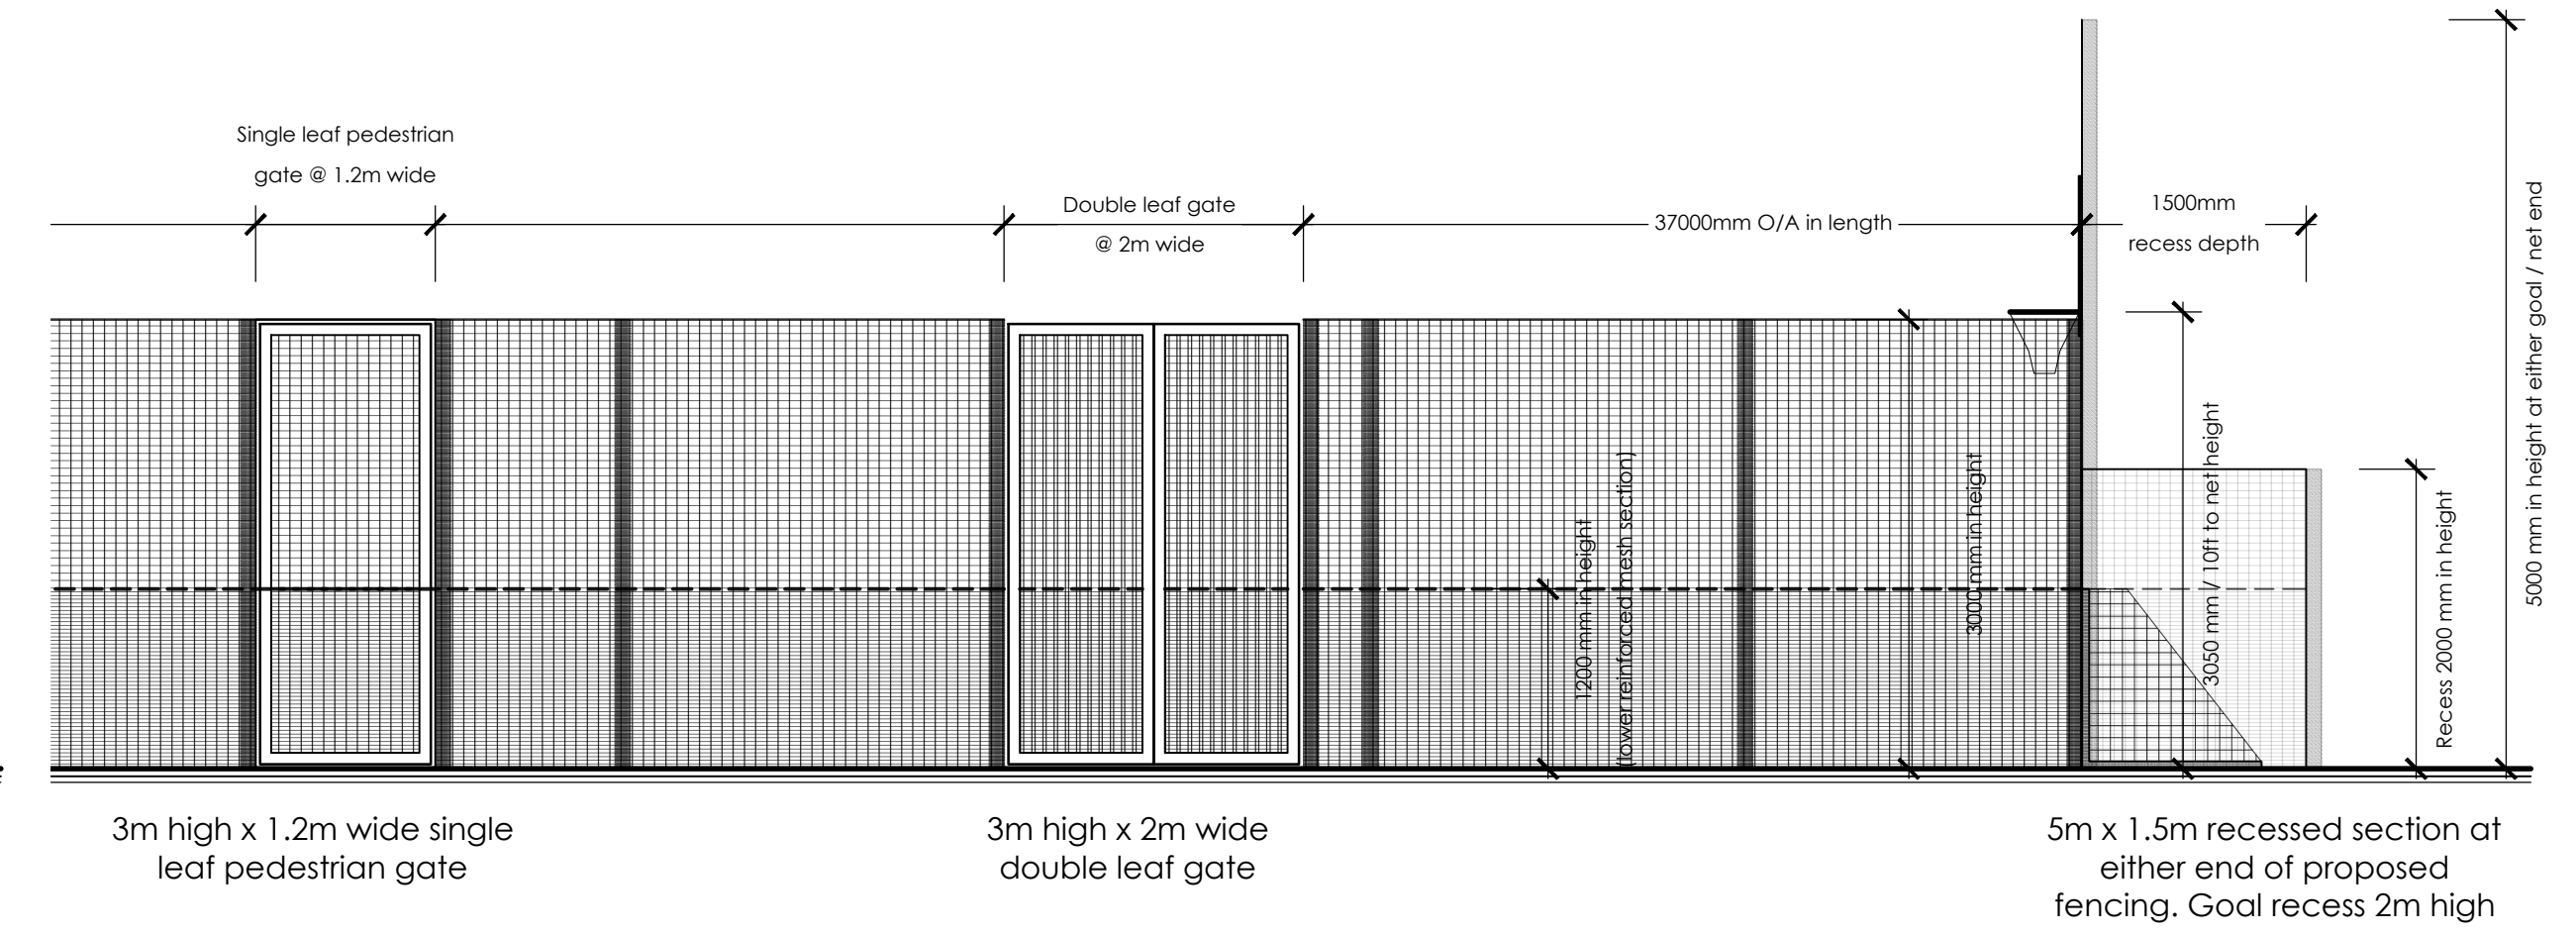

EAST (partial) / SIDE

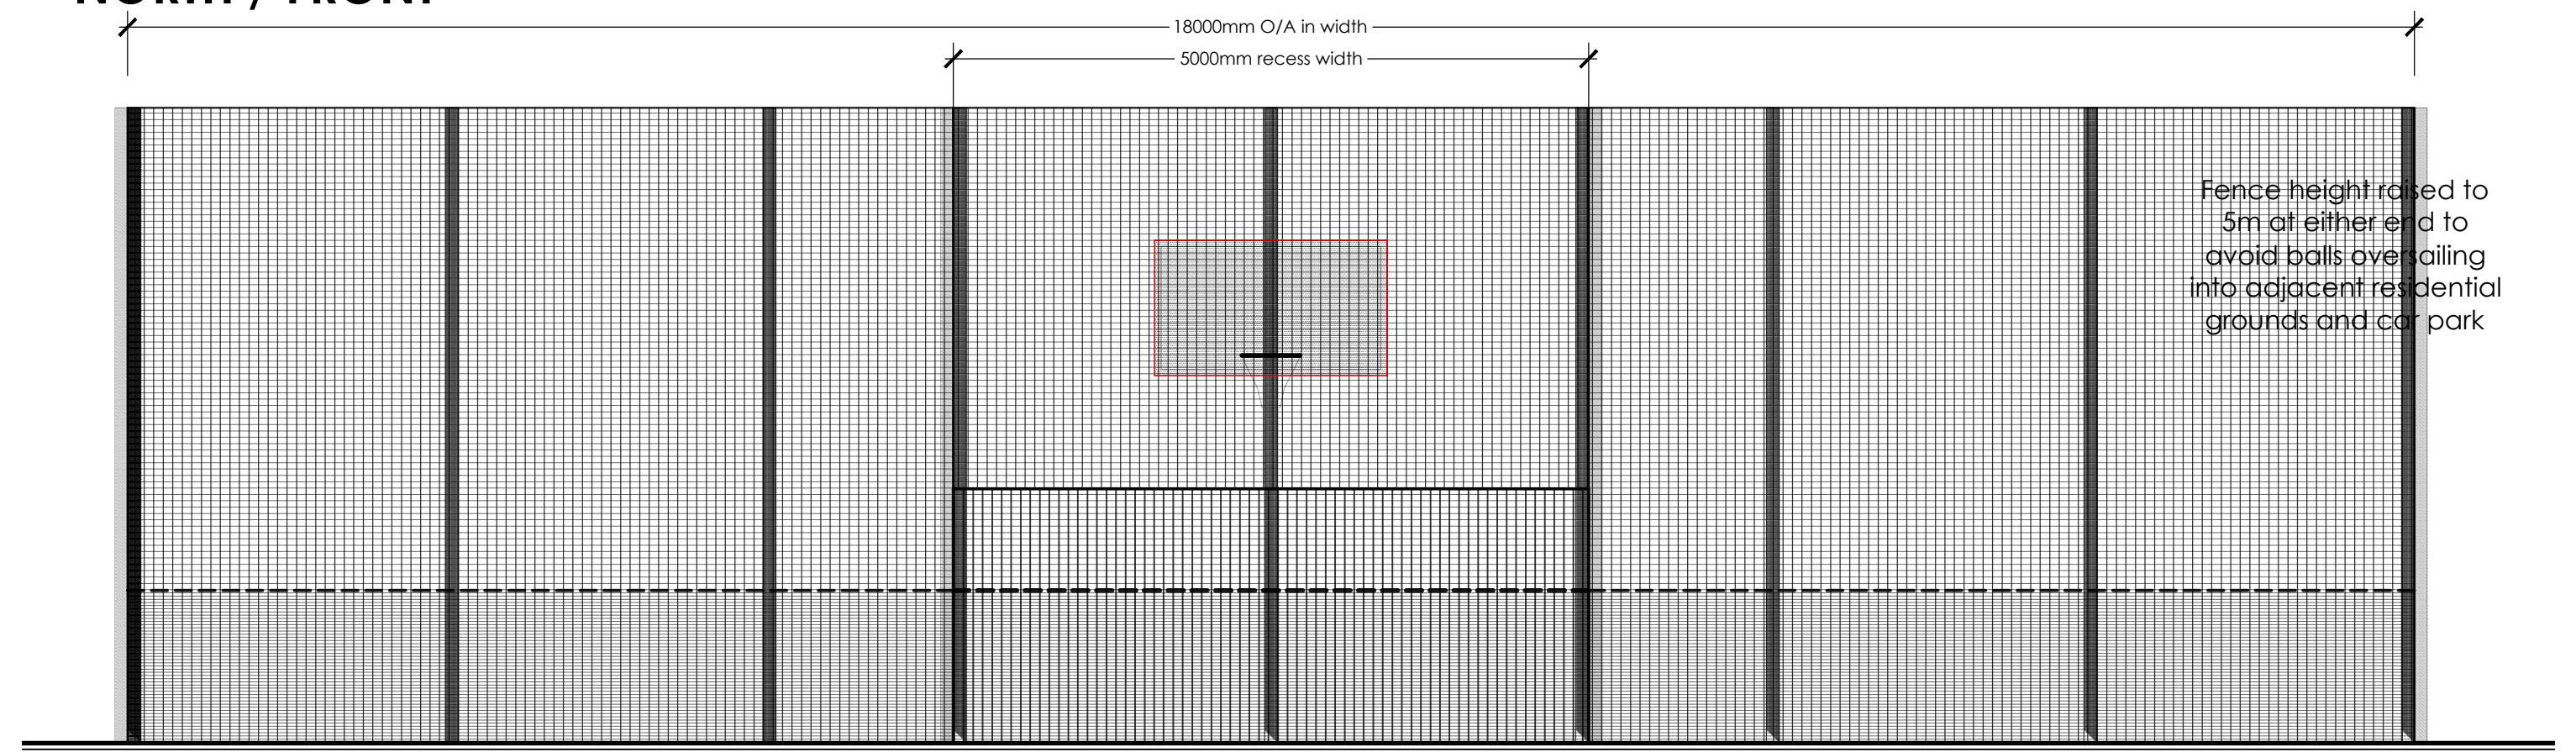

SOUTH / REAR

FENCING SPECIFICATION


Panels - 2515mm wide to 3000mm / 5000mm height. Mesh sizes are 76.2 x 12.7mm, and manufactured from 4mm and 6mm wires. Panels are constructed from a varimesh pattern to provide a lower rebound area 1200mm high. Post at 2.5m centres in matching RAL colour

The panel should incorporate a combination of increased vertical wire diameter (6mm) and the incorporation of double horizontal wires at 152.4mm centres on the rear face to enhance rigidity.

Gates - 3m high x 1.2m wide single leaf pedestrian gate and 3m high x 2m wide double leaf gate (available up to 5m wide)


Coating

Panels are manufactured from pre-galvanised wires with the polyester coating in Green RAL6005 (Moss Green)

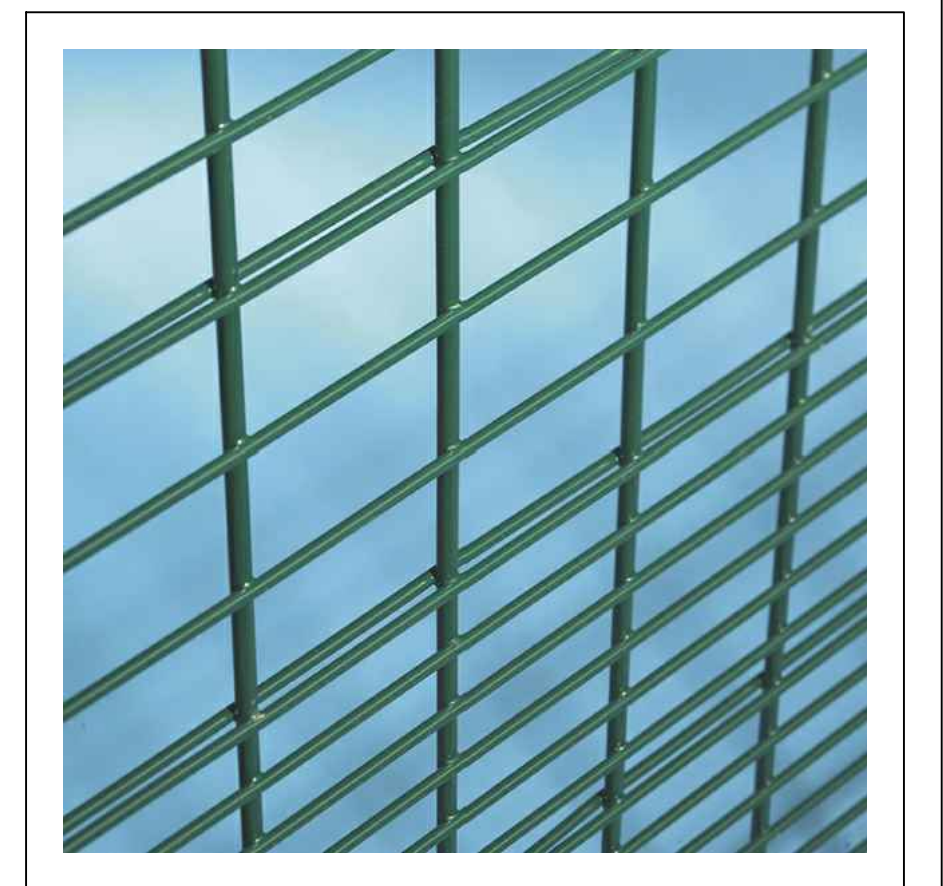

Indicative Mesh


SCALE n.t.s.

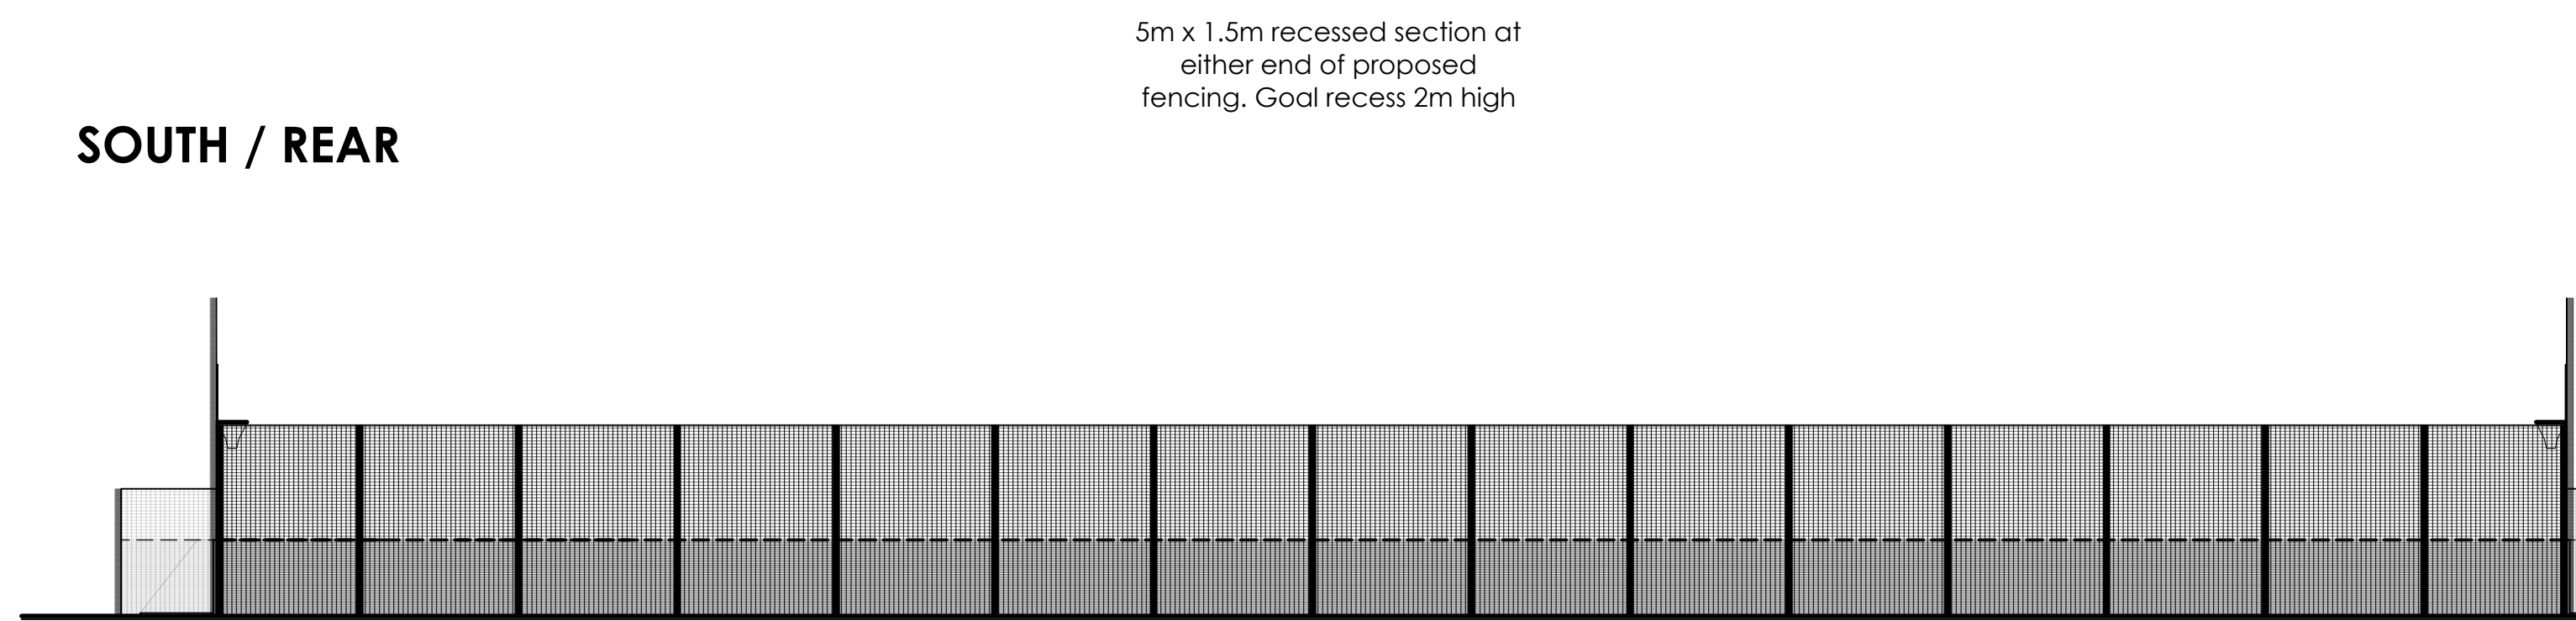


WEST / SIDE - SCALE 1:100

Proposed Container Unit

SCALE 1:50

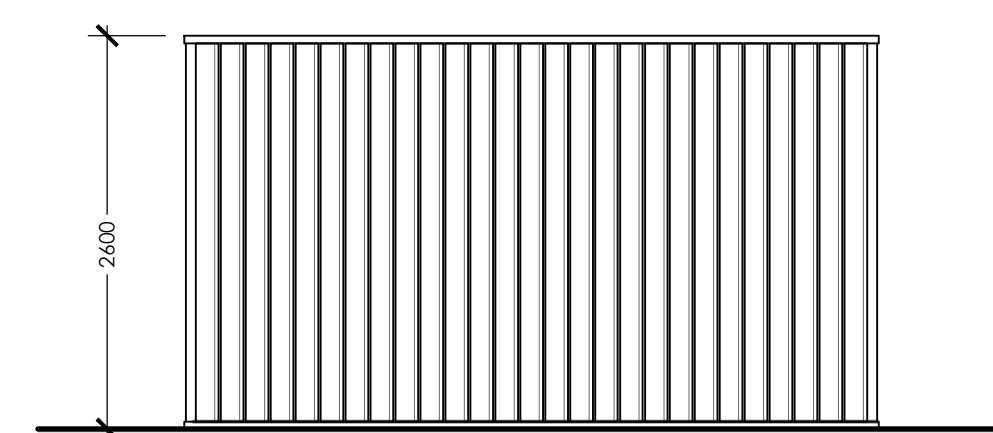


SIDE ELEVATION

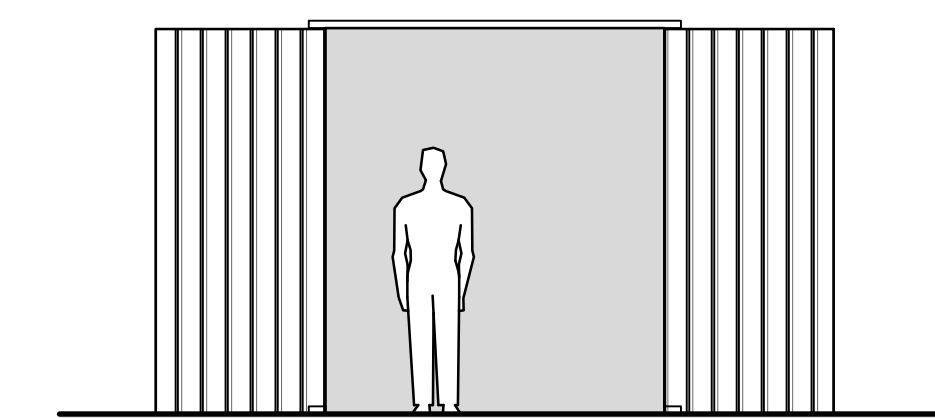


FRONT ELEVATION

- doors open


REV. A Proposals amended in accordance with comments following initial issue and container added 20.07.23 AF

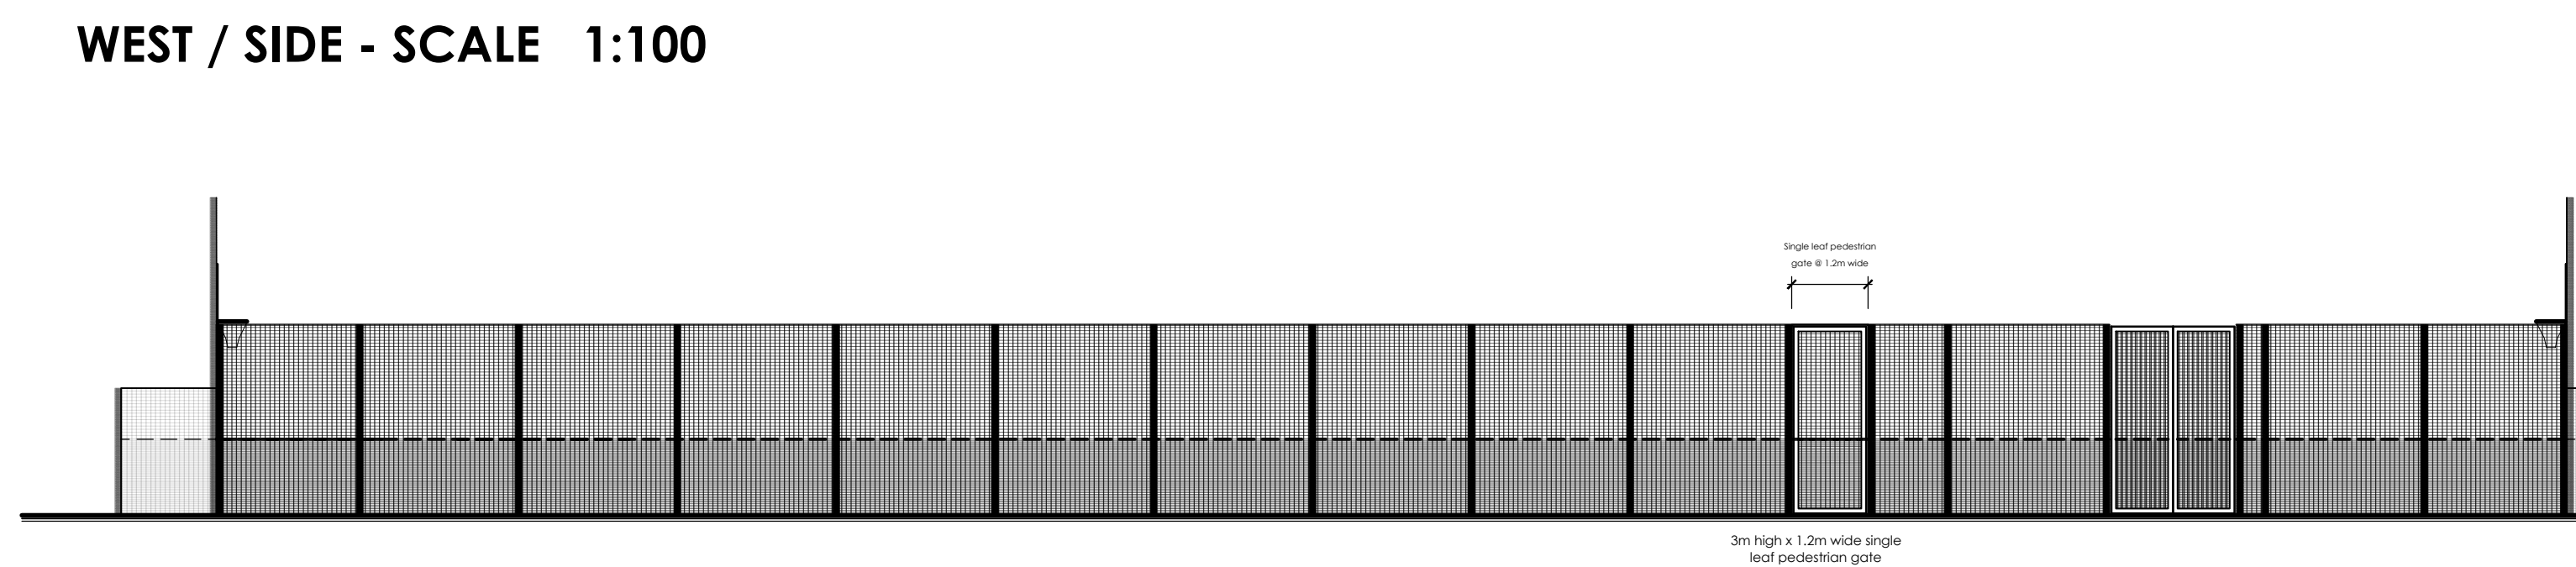

EAST / SIDE - SCALE 1:100

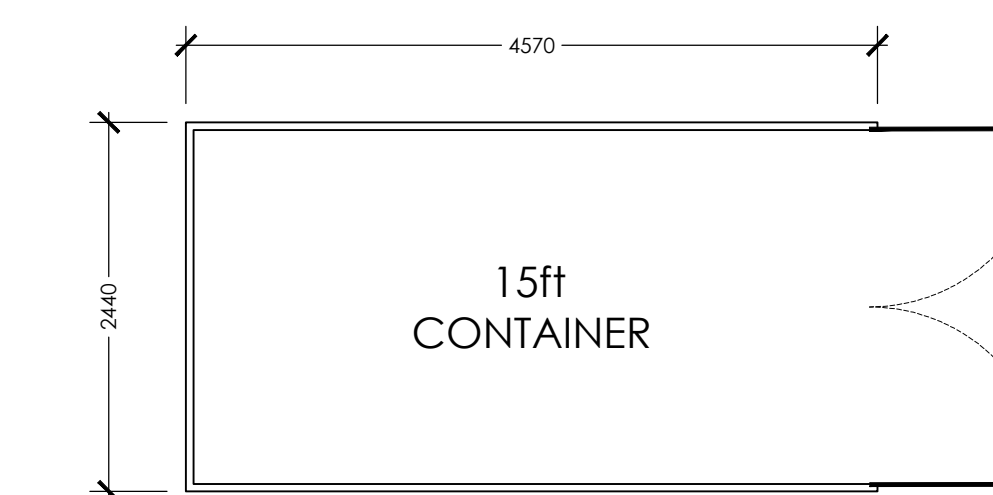

PLAN

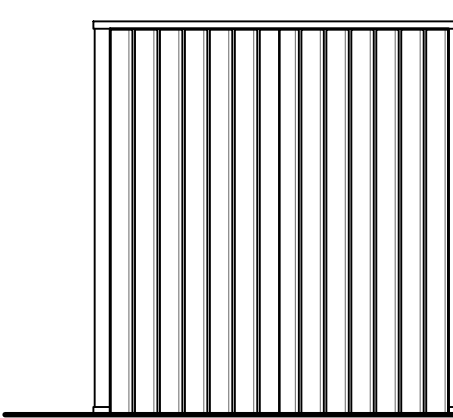

REAR ELEVATION

PROPOSED	PROJECT INFORMATION		APPLICANT NAME: Saxilby with Ingleby Parish Council		DATE: July 2023	
	PROPOSAL: PROPOSED FENCING ENCLOSURE TO EXISTING SAXILBY & DISTRICT MUGA (Multi Use Games Area)					
	SITE ADDRESS: St. Andrews Community Centre, William Street, Saxilby, Lincoln, LN1 2LP					
	DRAWING TITLE: Proposed Elevations Proposed Container Unit					
DRAWING NO: 23/228/Pr - 02		SCALE: As shown		REVISION: A		A1

PLANNING